


Replace Roof and Windows (B401)


Department of Veterans Affairs Medical Center

4100 West Third Street

Dayton, Ohio 45428

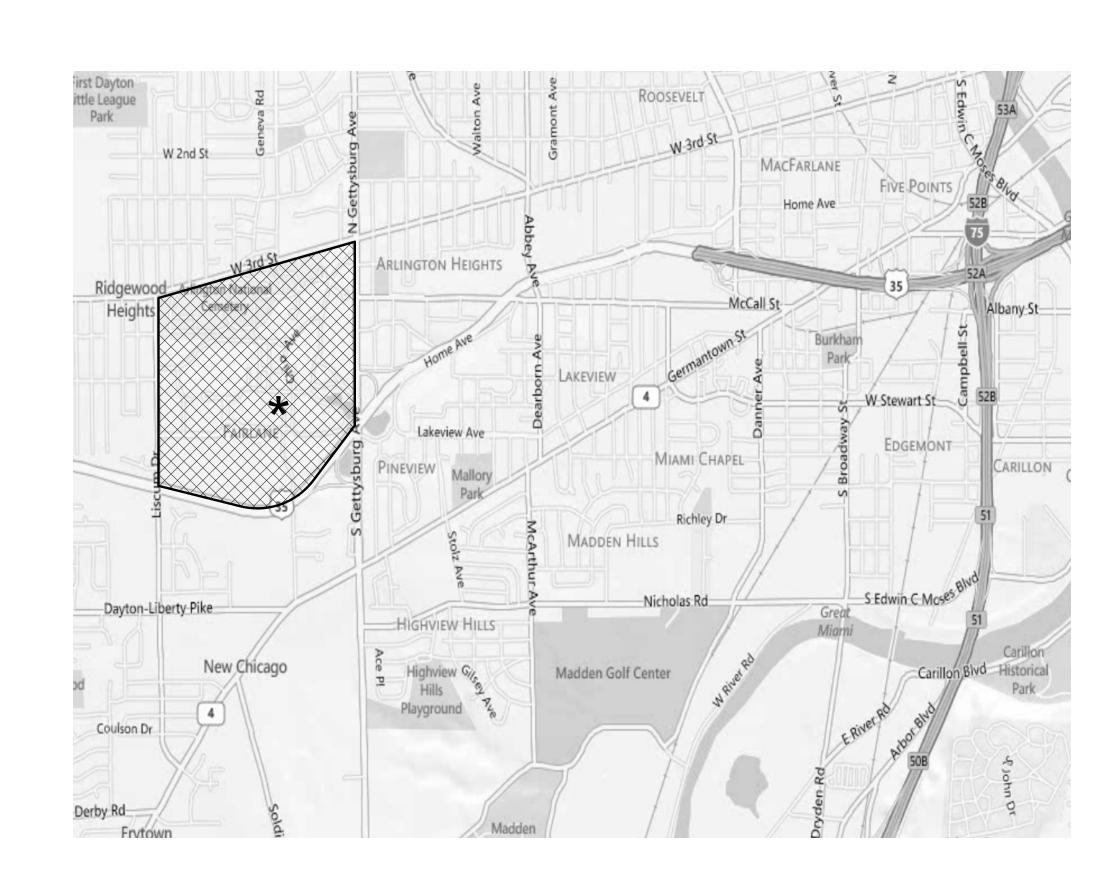



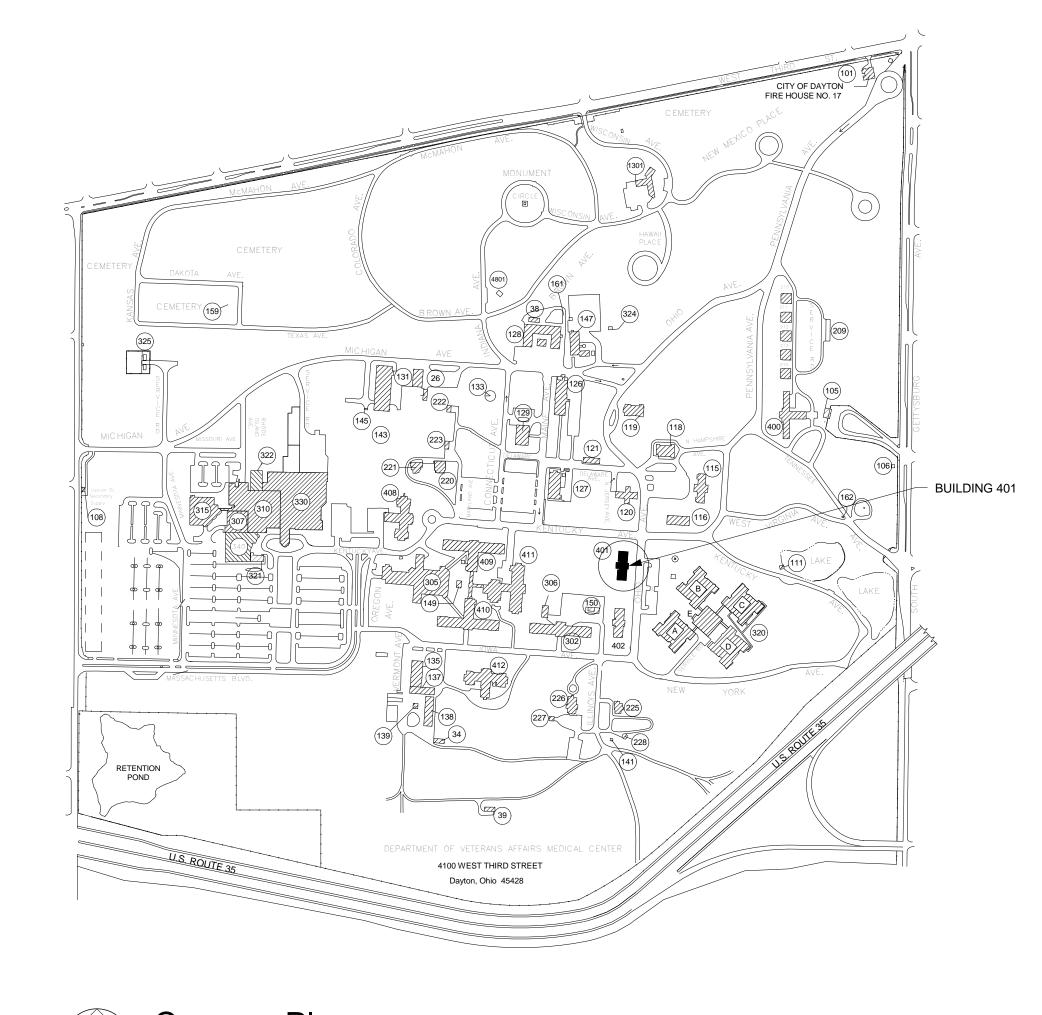

N Campus Plan
Scale: 1:6000

GENERAL CONSTRUCTION NOTES

- 1. ALL WORK SHALL COMPLY WITH THE LATEST NFPA 101 LIFE SAFETY CODE, INTERNATIONAL BUILDING CODE, AND OTHER COES AS IDENTIFIED IN VHA PROGRAM GUIDE PG-18-3, TOPIC 01, CODES, STANDARDS AND EXECUTIVE ORDERS WHICH CAN BE FOUND ON THE DEPARTMENT OF VETERAN AFFAIRS, TECHNICAL INFORMATION LIBRRARY WEBSITE.
- CONTRACTOR IS RESPONSIBLE TO VISIT THE SITE, EXAMINE AND ACCEPT EXISTING ONDITIONS PRIOR TO BIDDING. SITE VISITS TO BE COORDINATED WITH THE CONTRACTING OFFICER'S REPRESENTATIVE.
 CONTRACTOR IS RESPONSIBLE TO REPAIR AND/OR REFINISH, TO MATCH ADJACENT EXISTING SURFACES, ANY EXISTING MATERIALS TO REMAIN THAT ARE DAMAGED DURING THE COURSE OF DEMOLITION OR
- WHERE REMOVAL OF EXISTING WORK IS REQUIRED FOR INSTALLATION
 OF NEW WORK, CONTRACTOR SHALL REPAIR EXISTING CONSTRUCTION
 TO REMAIN OR PROVIDE NEW CONSTRUCTION TO MATCH EXISTING
 ADJACENT SURFACES TO REMAIN.
- 5. CONTRACTOR IS RESPONSIBLE TO FIELD VERIFY ALL CONDITIONS AND DIMENSIONS PRIOR TO ORDERING, FABRICATING OR INSTALLING NEW MATERIALS.
- 6. CONTRACTOR IS RESPONSIBLE TO VERIFY SIZES OF ALL EQUIPMENT, ETC. TO BE INSTALLED AS PART OF THIS PROJECT, AND WHERE NECESSARY, MAKE SPECIAL PROVISIONS TO INSTALL EQUIPMENT THAT IS TOO LARGE TO FIT THROUGH FINISHED OPENINGS.
- 7. CONTRACTOR SHALL PROVIDE COMPLETE AND FULLY OPERATIONAL SYSTEMS WHICH COMPLY WITH STATED CODES AND REGULATIONS. WHERE THE OMISSION OF A PART OR ELEMENT OF A SYSTEM WOULD RESULT IN THE NON-OPERATION, OR INCORRECT OPERATION OF A SYSTEM, CONTRACTOR SHALL INCLUDE SAID PART OR ELEMENT AS PART OF THE WORK.
- 8. CONTRACTOR SHALL COORDINATE PARKING, MATERIALS AND EQUIPMENT STAGING AND DUMPSTER LOCATIONS WITH CONTRACTING OFFICER'S REPRESENTATIVE (COR).

DRAWING INDEX

401G001 COVER SHEET 401A100 FLOOR PLANS 401A101 ROOF PLAN

401A201 EXTERIOR ELEVATIONS
401A202 EXTERIOR ELEVATIONS
401A501 ROOF DETAILS

401A502 EXISTING CONDITIONS PHOTOGRAPHS
401A601 WINDOW ELEVATIONS
401A602 WINDOW DETAILS


GRAHPIC SYMBOLS





X SIM SECTION/DETAIL NUMBER DRAWING NUMBER

? NOTE

WINDOW OPENING

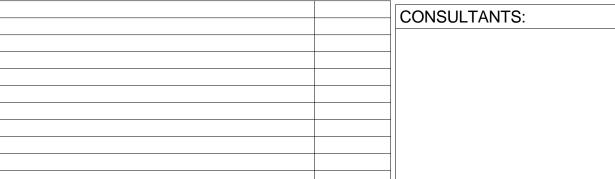

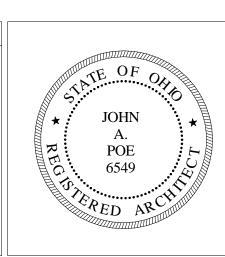

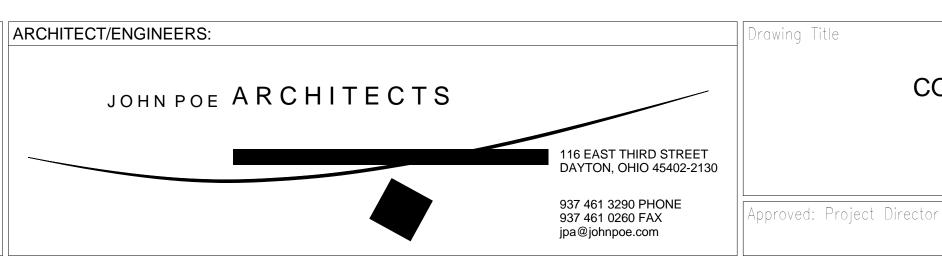



Peplace Roof and Windows (B401)

VA Project No. 552-15-208
JPA Project No. 13005.00


Building Number 401


Drawing Number 401

VA Project No. JPA Project No. 13005.00

Building Number Construction and Facilities Management

401 Management Department of Construction and Facilities Management

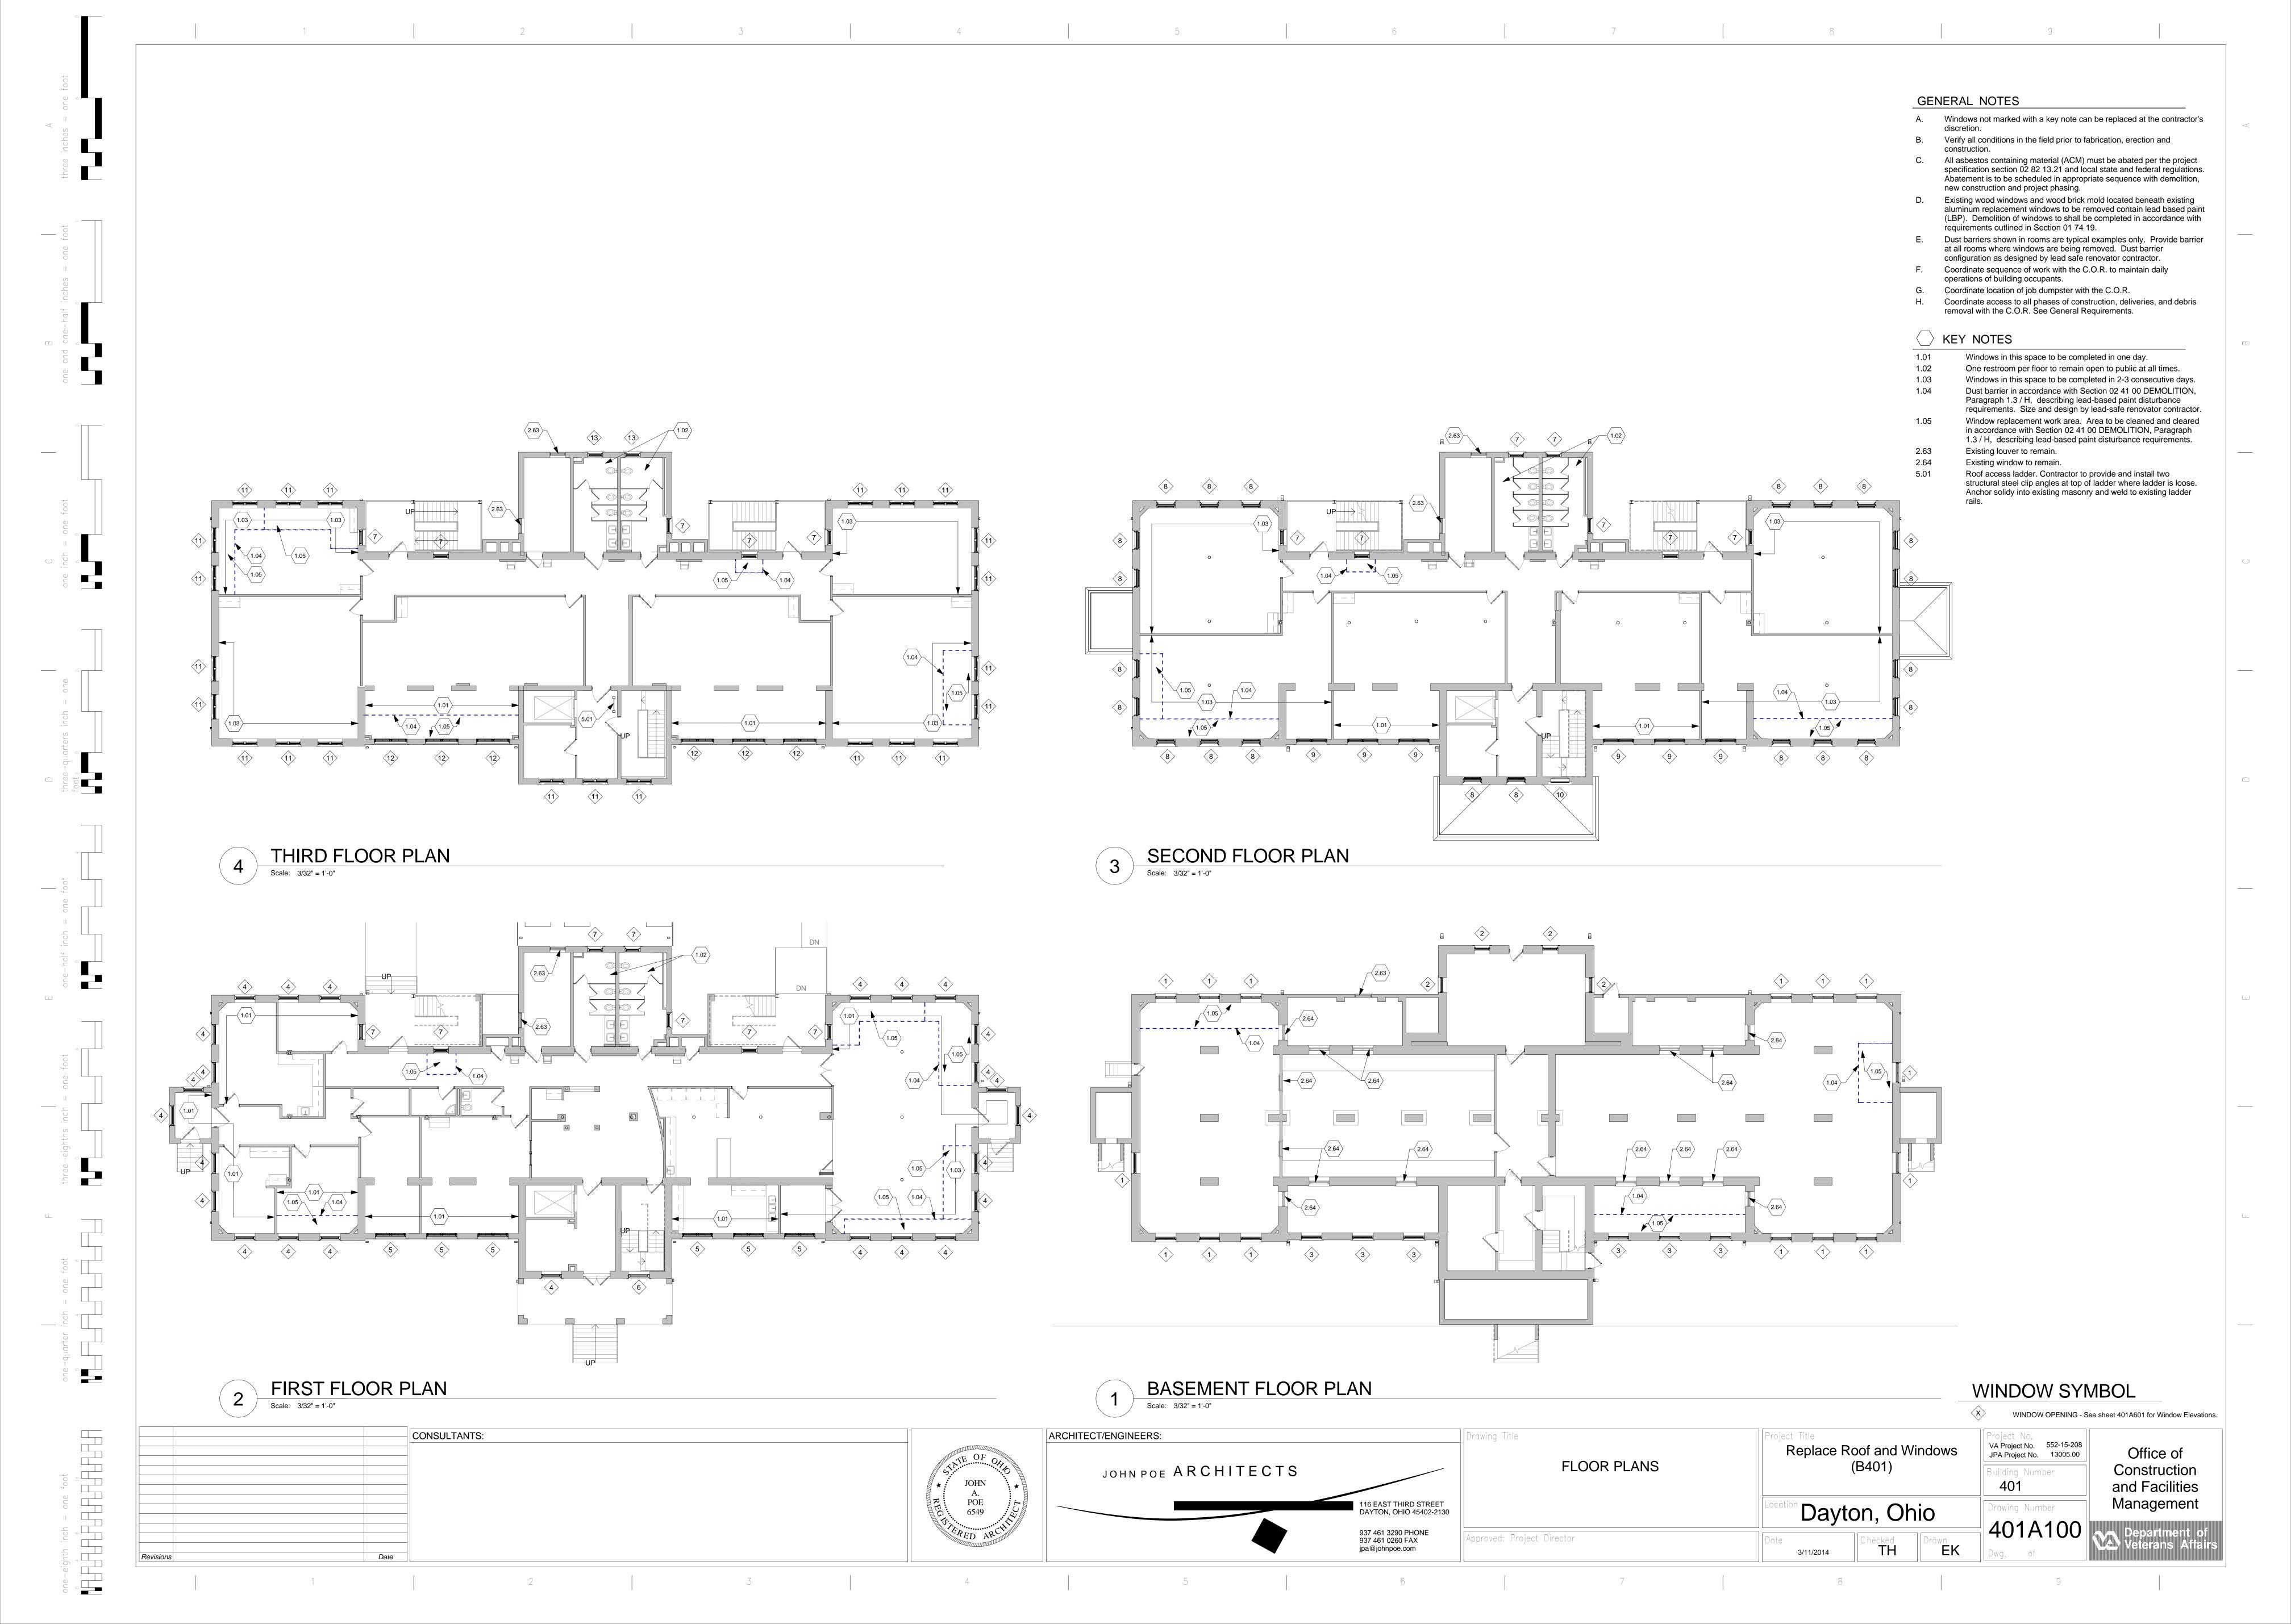

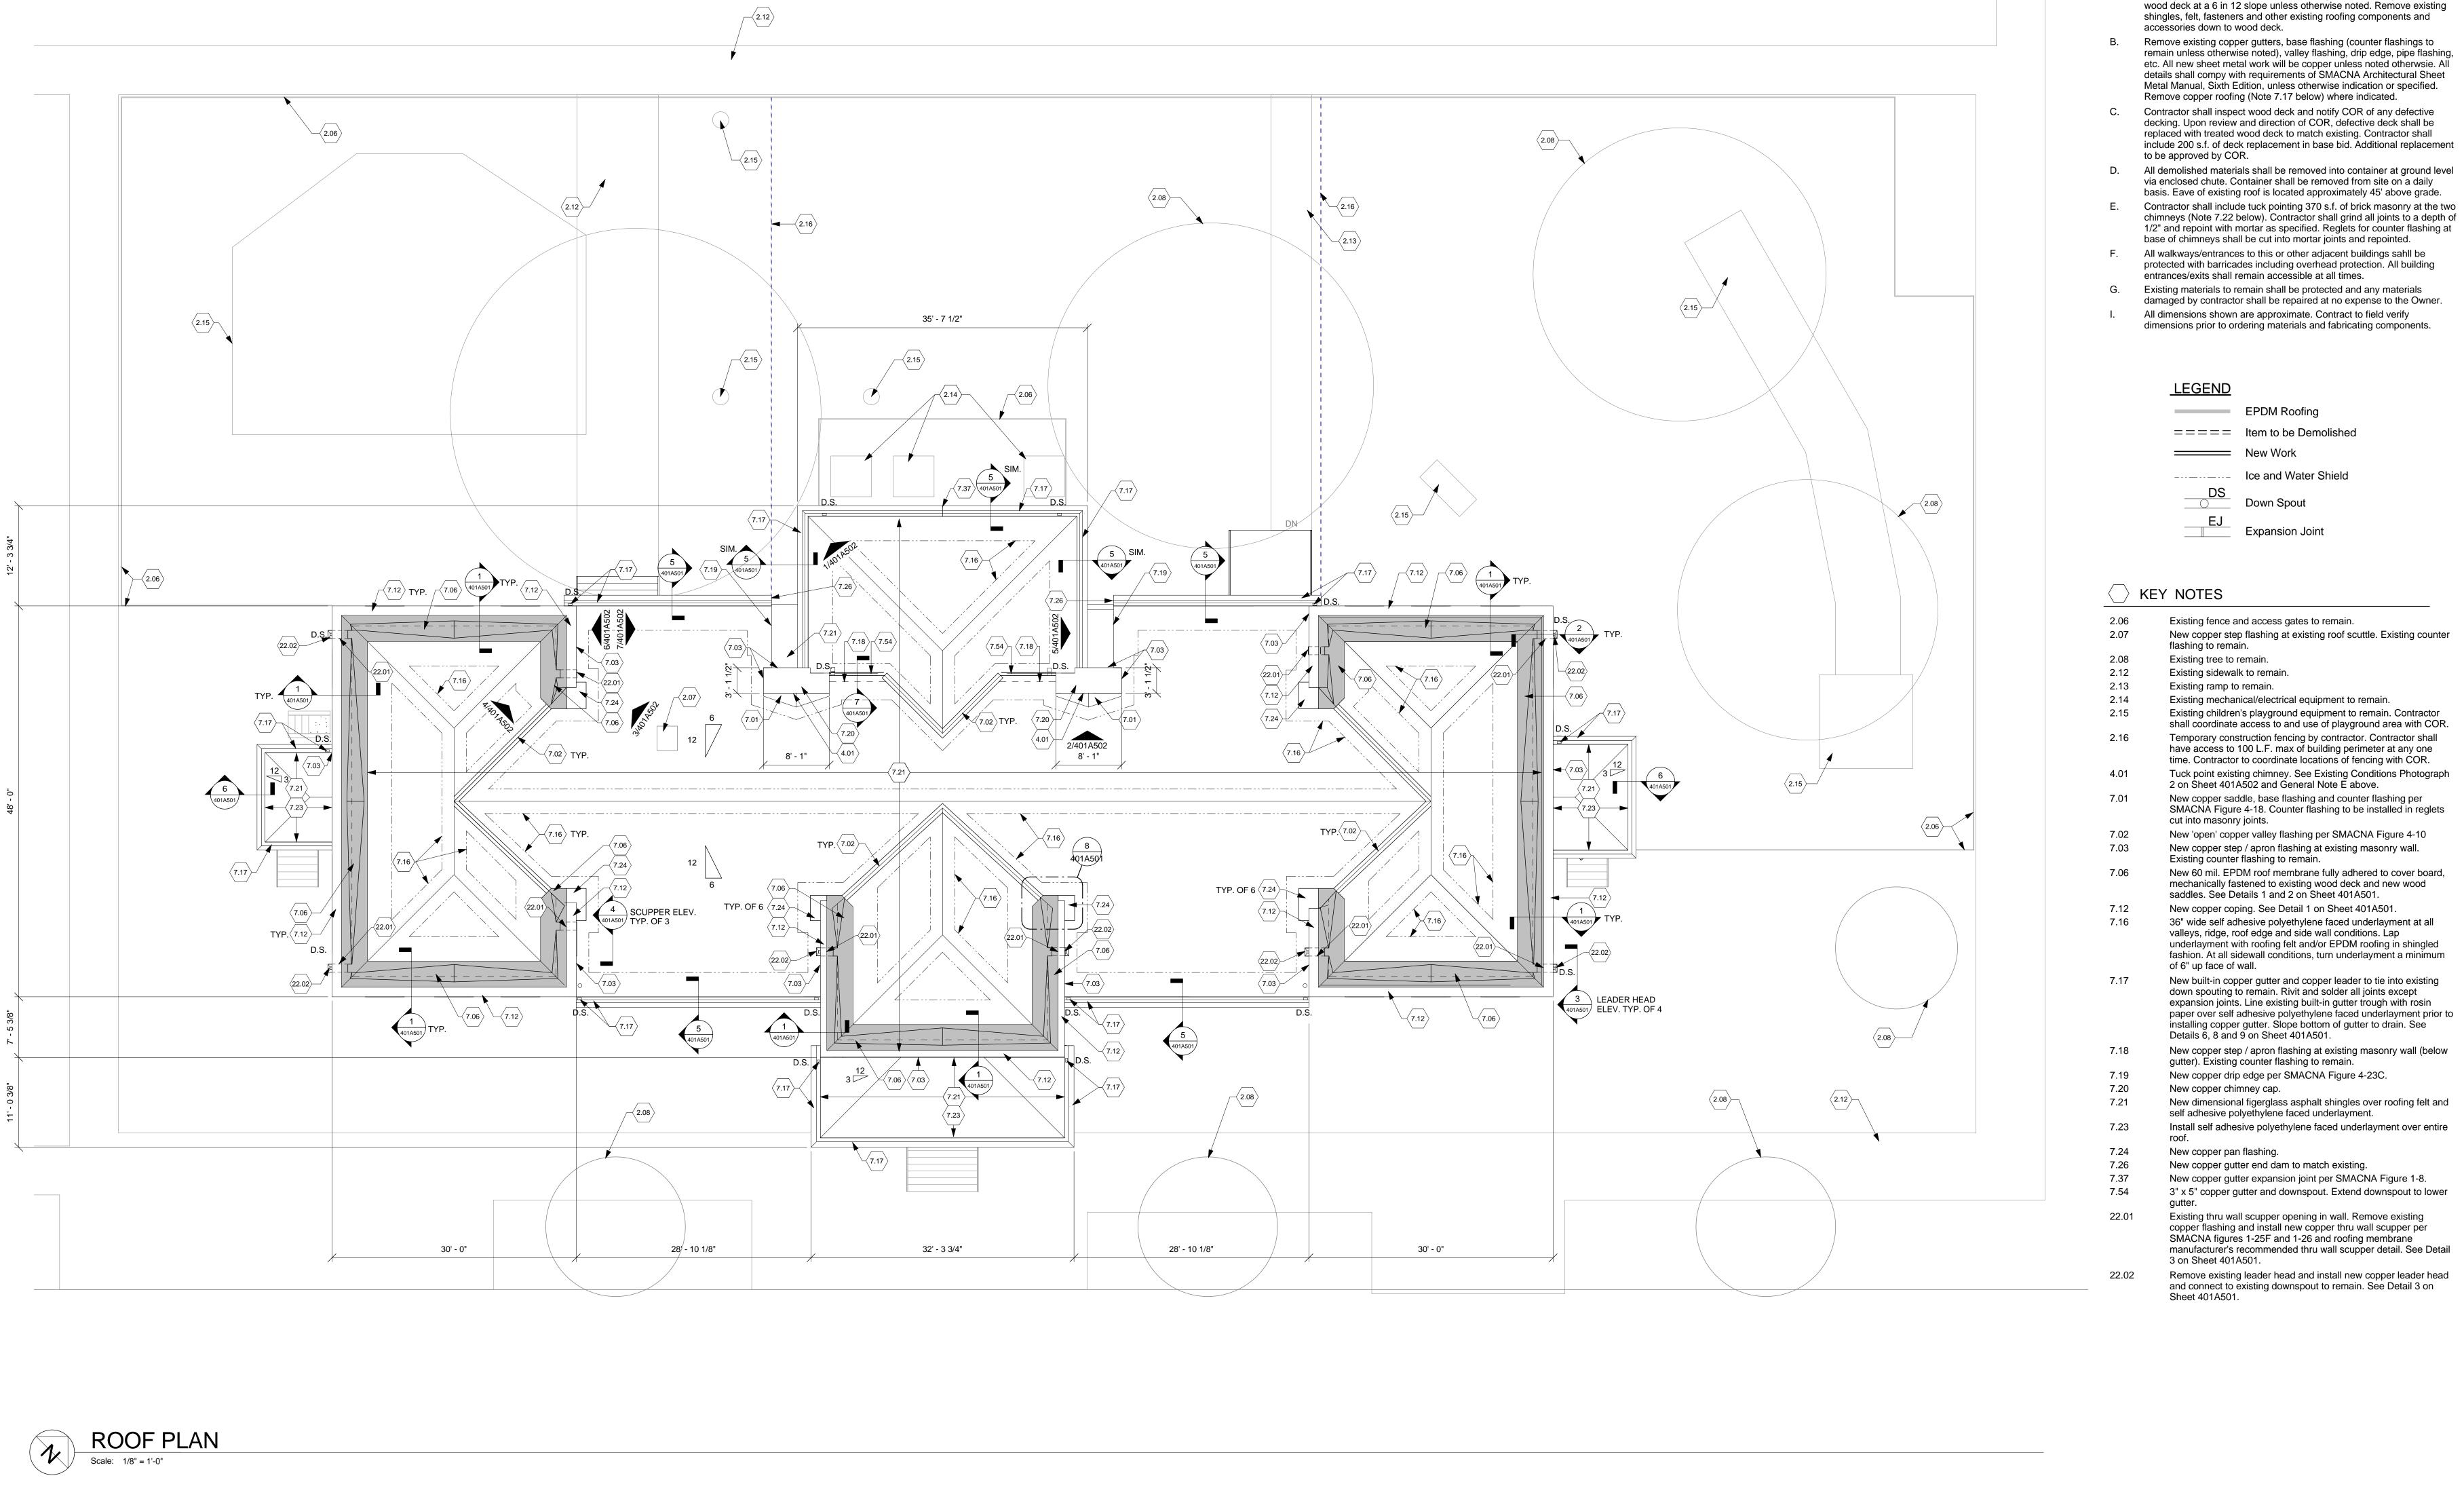

ARCHITECT/ENGINEERS:

POE 6549

JOHN POE ARCHITECTS

Drawing Title

Approved: Project Director

116 EAST THIRD STREET DAYTON, OHIO 45402-2130

937 461 3290 PHONE

937 461 0260 FAX jpa@johnpoe.com

ROOF PLAN

8

CONSULTANTS:

Date

Project No. 552-15-208 Office of JPA Project No. 13005.00 Construction and Facilities Management 401A101

Replace Roof and Windows

(B401)

Dayton, Ohio

3/11/2014

401

Drawing Number

GENERAL NOTES

Existing roof is a dimensional asphalt shingle over building felt over 1x8

401-ATTIC FLOOR 422' - 9 3/4" 401-THIRD FLOOR 409' - 1 1/4" 401-SECOND 395' - 3 1/4" 401-<u>FIRST FLOOR</u> 381' - 6" 40<u>1-BASEMENT</u> 373' - 0"

NORTH ELEVATION

Scale: 1/8" = 1'-0"

GENERAL NOTES

- A. Verify all conditions prior to fabrication, erection, and installation.
- Completely remove all sealant from window openings at exterior and interior. Clean existing brick veneer to like new condition.
- Site conditions not shown for drawing clarity. See Site Plan for equipment locations and limits to access.
- Coordinate with C.O.R. the relocate of furniture and equipment within rooms, prior to window installation to gain clear access to interior side of existing
- All windows are to be single hung units, unless noted otherwise.
- Clean, prep, and paint original steel lintels to appear like new.
- Contractor shall coordinate the relocation of children on a per room basis with the C.O.R. prior to beginning work.
- Existing stone sill, soldier course, and brick arch to remain. Protect in place. Remove existing aluminum window system, wood brick mold and wood transom sashes at all openings indicated to receive new window. Remove in accordance with requirements of section 02 41 00 Demolition, paragraph

1.3/H. See typical details 1,2,3 & 4 on sheet 401A602.


KEY NOTES

- Carefully remove existing railing on interior side of window, and store for reinstallation. Prep area for new work. At completion of window installation, reinstall railing back into orginal location. Prior to new work, remove security bars from window opening,
- and prepare area for new construction. Relocate lockers, coordinate with C.O.R. prior to new work. Return
- lockers to orginal location at the end of new work. 7.12 New copper coping. See Detail 1 on Sheet 401A501.
- New built-in copper gutter and copper leader to tie into existing down spouting to remain. Rivit and solder all joints except expansion joints. Line existing built-in gutter trough with rosin paper over self adhesive polyethylene faced underlayment prior to installing copper gutter. Slope bottom of gutter to drain. See Details 6, 8 and 9 on Sheet 401A501.
- New dimensional asphalt shingle roof. See Roof Plan Sheet
- Remove existing leader head and install new copper leader head and connect to existing downspout to remain. See Detail 3 on



WINDOW SYMBOL

WINDOW OPENING - See sheet 401A601 for Window Elevations.

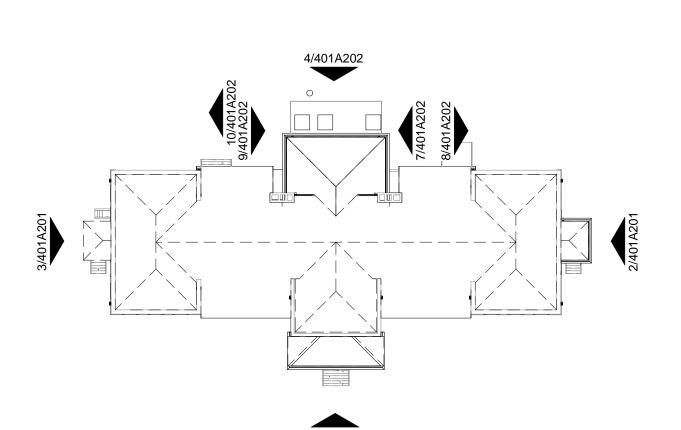

KEYPLAN

Drawing Title

EXTERIOR ELEVATIONS

22.02 TYP.

401-ATTIC FLOOR 422' - 9 3/4"

401-THIRD FLOOR 409' - 1 1/4"

401-SECOND

401-FIRST FLOOR 381' - 6"

401-BASEMENT 373' - 0"

-395' - 3 1/4"

7.12 TYP.

Replace Roof and Windows (B401)

Project No.
VA Project No. 552-15-208
JPA Project No. 13005.00 401

Office of Construction and Facilities Management

Drawing Number 401A201

Scale: 1/8" = 1'-0"

CONSULTANTS:

Date


SOUTH ELEVATION

POE 6549

ARCHITECT/ENGINEERS: JOHN POE ARCHITECTS 116 EAST THIRD STREET DAYTON, OHIO 45402-2130 937 461 3290 PHONE 937 461 0260 FAX jpa@johnpoe.com

Approved: Project Director

Dayton, Ohio TH 3/11/2014

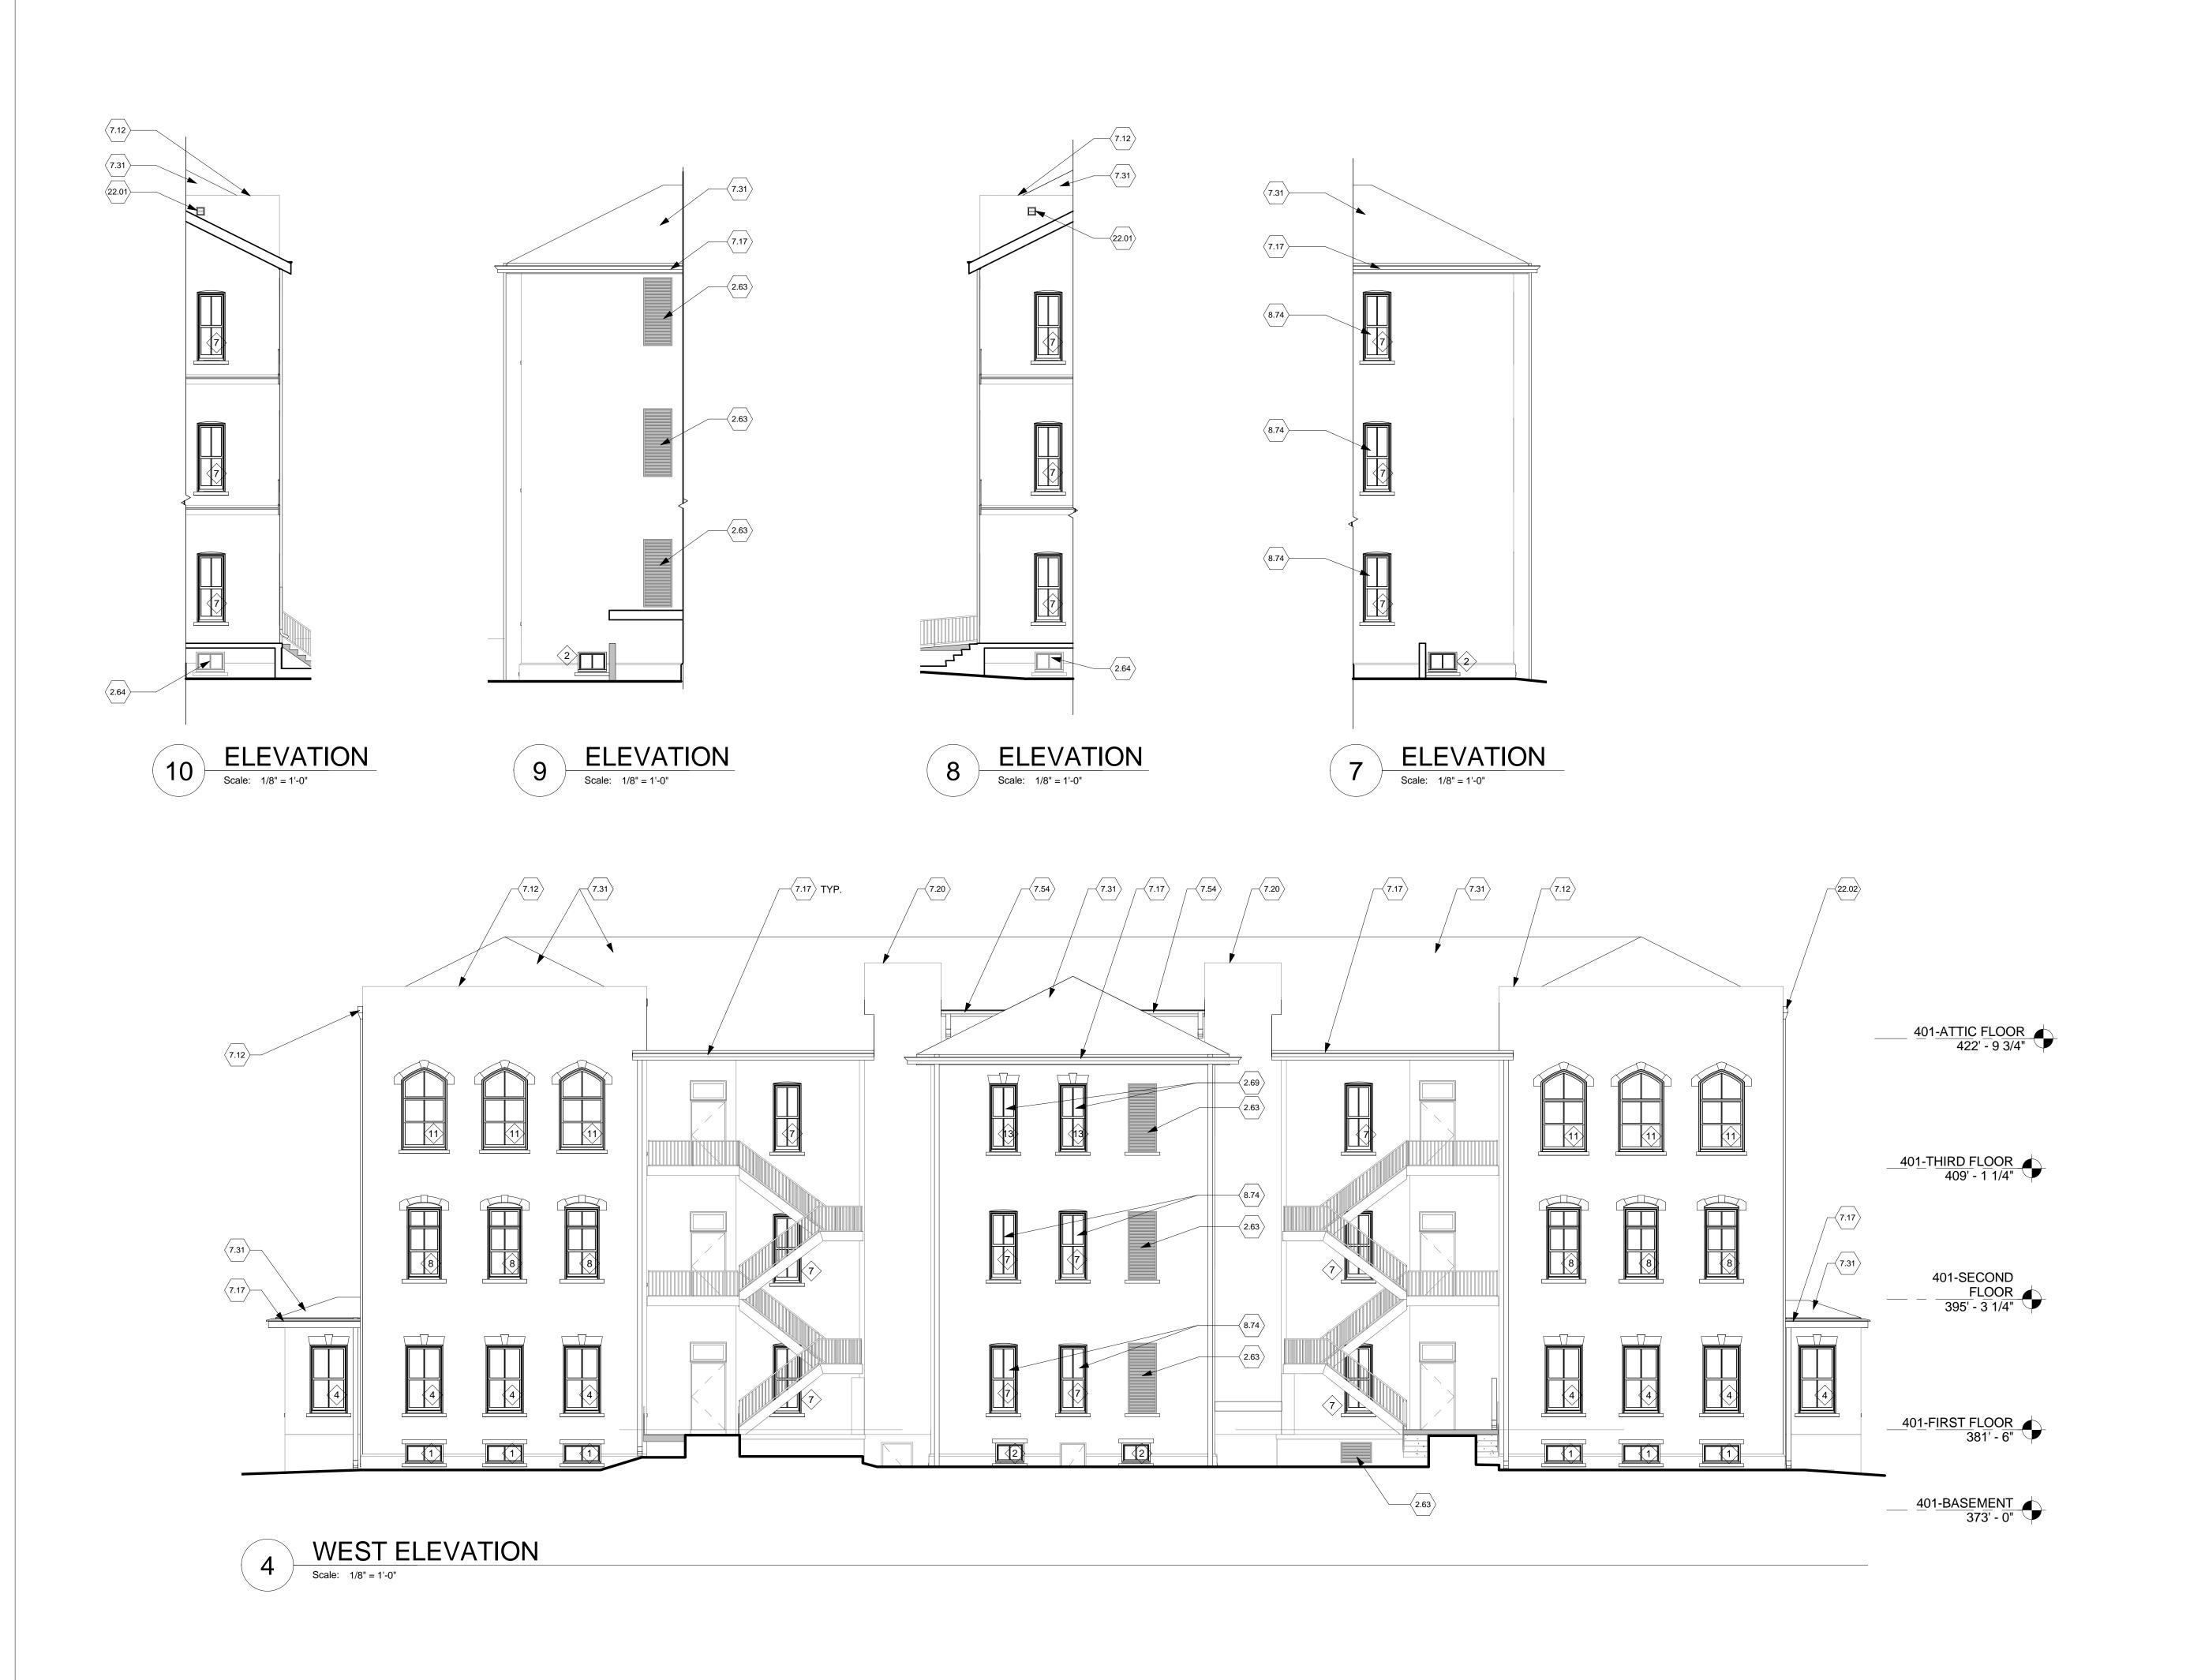

GENERAL NOTES

- A. Verify all conditions prior to fabrication, erection, and installation.
- B. Completely remove all sealant from window openings at exterior and interior. Clean existing brick veneer to like new condition.
- C. Site conditions not shown for drawing clarity. See Site Plan for equipment
- D. Coordinate with C.O.R. the relocate of furniture and equipment within rooms, prior to window installation to gain clear access to interior side of existing
- E. All windows are to be single hung units, unless noted otherwise.
- Clean, prep, and paint original steel lintels to appear like new.
 Contractor shall coordinate the relocation of children on a per room basis with
- the C.O.R. prior to beginning work.
- H. Existing stone sill, soldier course, and brick arch to remain. Protect in place.
 J. Remove existing aluminum window system, wood brick mold and wood transom sashes at all openings indicated to receive new window. Remove in
- accordance with requirements of section 02 41 00 Demolition, paragraph 1.3/H. See typical details 1,2,3 & 4 on sheet 401A602.


KEY NOTES

- 2.63 Existing louver to remain.
- Existing window to remain.
- 2.69 Line of ceiling beyond.7.12 New copper coping. See Detail 1 on S
 - New copper coping. See Detail 1 on Sheet 401A501.
 - New built-in copper gutter and copper leader to tie into existing down spouting to remain. Rivit and solder all joints except expansion joints. Line existing built-in gutter trough with rosin
 - expansion joints. Line existing built-in gutter trough with rosin paper over self adhesive polyethylene faced underlayment prior to installing copper gutter. Slope bottom of gutter to drain. See Details 6, 8 and 9 on Sheet 401A501.
- 7.20 New copper chimney cap.
- 7.31 New dimensional asphalt shingle roof. See Roof Plan Sheet
- 7.54 3" x 5" copper gutter and downspout. Extend downspout to lower
- 8.74 Obscure glass this window.
 - 2.01 Existing thru wall scupper opening in wall. Remove existing copper flashing and install new copper thru wall scupper per SMACNA figures 1-25F and 1-26 and roofing membrane manufacturer's recommended thru wall scupper detail. See Detail
- 3 on Sheet 401A501.

 Remove existing leader head and install new copper leader head
- Remove existing leader head and install new copper leader head and connect to existing downspout to remain. See Detail 3 on Sheet 401A501.

WINDOW SYMBOL


WINDOW OPENING - See sheet 401A601 for Window Elevations.

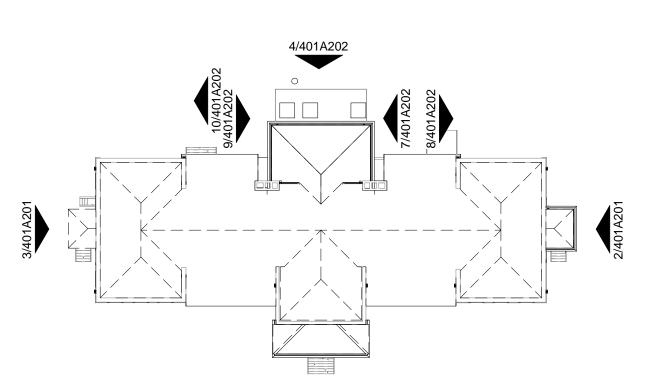




Revisions Date

CONSULTANTS:

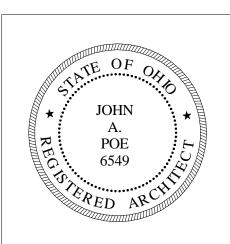

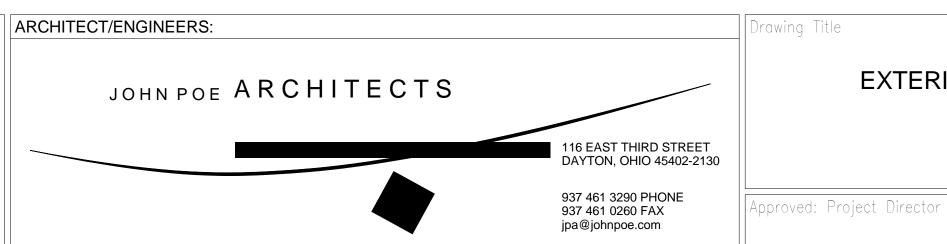

EXTERIOR ELEVATIONS

Replace Roof and Windows
(B401)

3/11/2014

Dayton, Ohio

(B401)

TH


Project No.
VA Project No. 552-15-208
JPA Project No. 13005.00

Building Number
401

Office of Construction and Facilities Management

Drawing Number 401A202

Department of Veterans Affairs

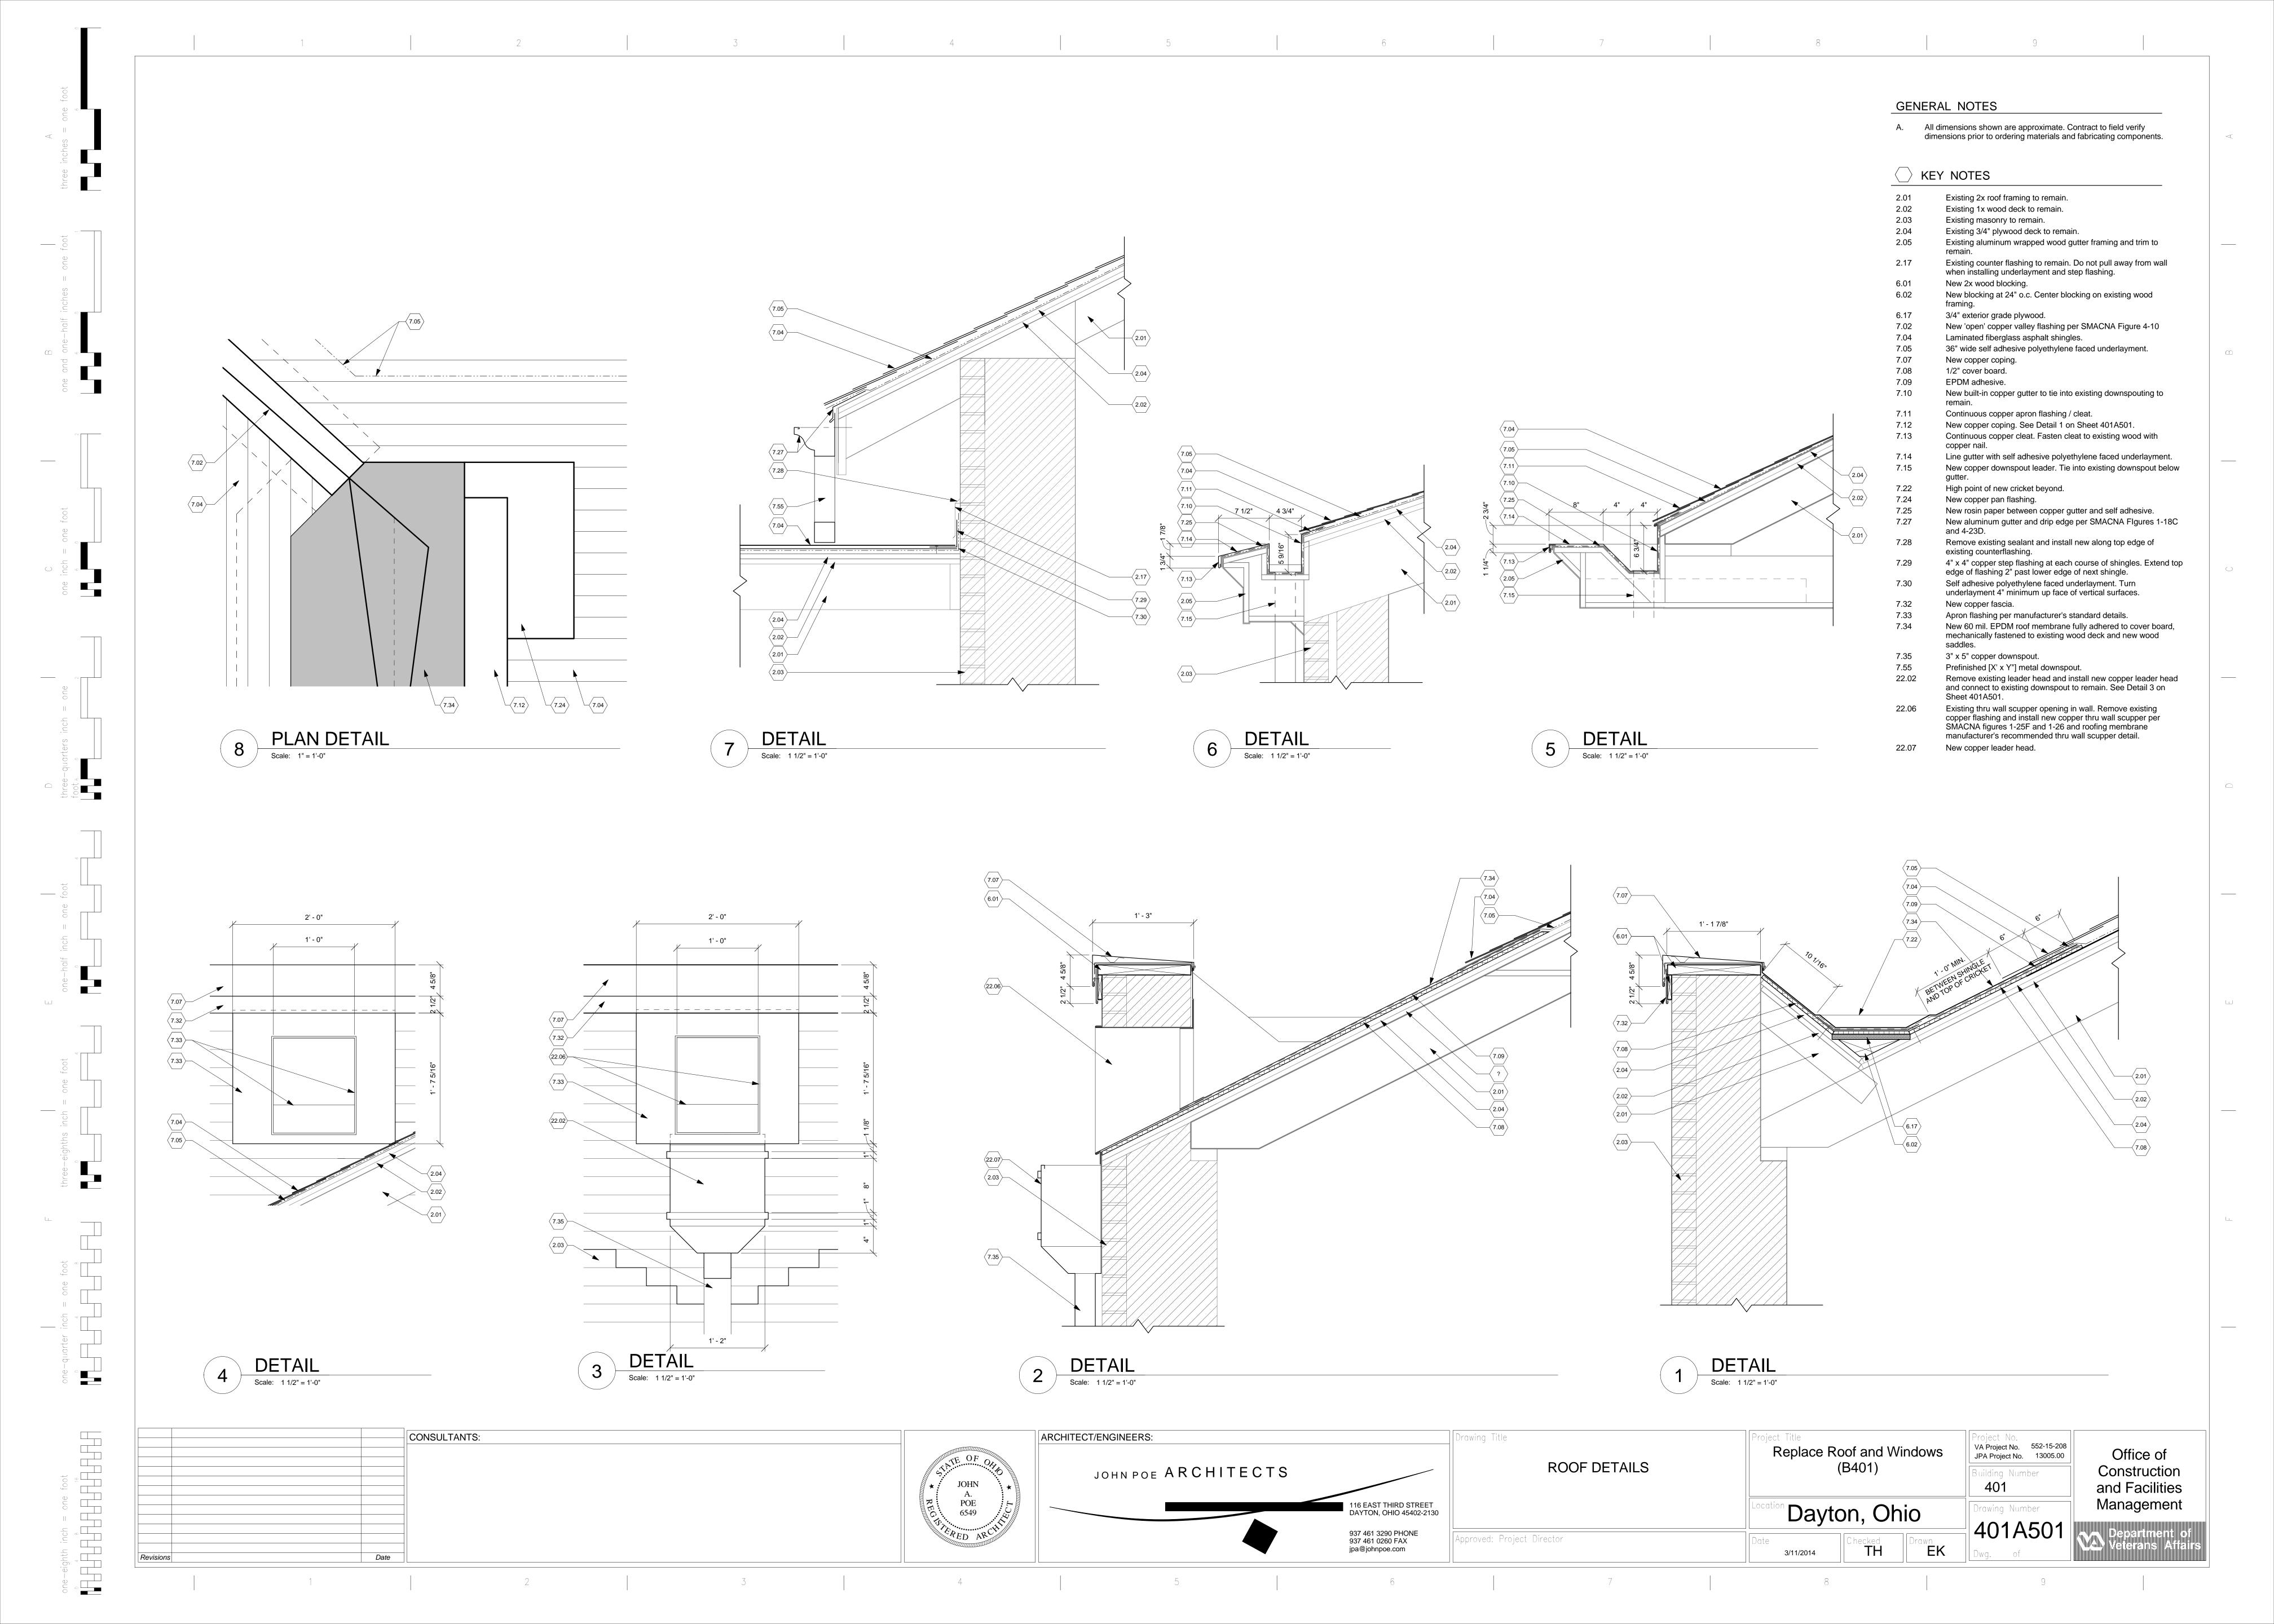



Office of

Construction

and Facilities

Management

Department of Veterans Affairs

Building Number

Drawing Number

401

